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PROFESSOR ANDERSON FARMINGDALE STATE COLLEGE 2350 BROADHOLLOW ROAD FARMINGDALE NY 11735

LANTERN AT THE CORNER A THEATER FOR THE VILLAGE

GENERAL NOTES

- 1. THE CONTRACTOR WILL CHECK AND VERIFY ALL CONDITIONS AT THE SITE BEFORE STARTING OF WORK AND HE/SHE WILL FAMILIARIZE HIMSELF/HERSELF WITH THE INTENT OF THESE PLANS AND MAKE SURE WORK AGREES WITH SAME. IF DURING THE CONSTRUCTION A CONDITION EXISTS WHICH DISAGREES WITH THAT INDICATED ON THE PLANS, THE CONTRACTOR WILL STOP WORK AND NOTIFY ARCHITECT. SHOULD HE/SHE FAIL TO FOLLOW THIS PROCEDURE AND CONTINUE WITH WORK, HE/SHE WILL ASSUME ALL RESPONSIBILITY AND LIABILITY ARISING FROM HIS/HER ACTIONS.
- 2. VERIFY EXACT LAYOUT CAPABILITY WITH ALL EXISTING CONDITIONS AND COORDINATE ALL WORK TO BE UNDERTAKEN, INCLUDING PLUMBING, MECHANICAL, AND ELECTRICAL TRADES, PRIOR TO BEGINNING ANY WORK. CONTRACTOR WILL BE RESPONSIBLE FOR ALL TEMPORARY MEASURES, TIME LOST, CHANGES TO THE WORK SCOPE WITH ANY ADDITIONAL COMPENSATION IF CONTRACTOR FAILS TO PROVIDE AFOREMENTIONED VERIFICATIONS AND COORDINATION PRIOR TO COMMENCING WORK.
- 3. ALL PENETRATIONS REQUIRED TO ACCOMMODATE ALL WORK DETAILED OR SPECIFIED FOR THEIR SCOPE SHALL BE LOCATED SIZED, MADE & VERIFIED BY THE CONTRACTOR.
- 4. DISTURB ONLY THE AREAS OF THE SITE AFFECTED BY NEW CONSTRUCTION, UNLESS NOTED OTHERWISE. CONTRACTOR SHALL PROTECT ALL ADJACENT EXISTING CONSTRUCTION, ITEMS, FINISHES, ADJOINING PROPERTIES, ETC. AND SHALL PATCH, REPAIR AND/OR REPLACE, AND REFINISH AS REQUIRED TO RESTORE ANY AND ALL AREAS DAMAGED DURING CONSTRUCTION.
- CONTRACTORS SHALL BE RESPONSIBLE FOR MAINTAINING WATER-TIGHT WEATHER PROTECTION THROUGHOUT ALL WORK AREA & EXISTING AREAS IMMEDIATELY ADJACENT TO THOSE WORK AREAS, FOR THE DURATION OF THE **ENTIRE PROJECT**
- 6. THE CONTRACTOR SHALL BE FULLY RESPONSIBLE FOR THE SAFETY OF THE PUBLIC AND THE PROPERTY DURING CONSTRUCTION OPERATIONS AND UNTIL COMPLETION OF ALL WORK.
- 7. THE CONTRACTOR WILL BE RESPONSIBLE FOR THE ACTS AND OMISSIONS OF ALL HIS/HER EMPLOYEES AND ALL SUBCONTRACTORS, THEIR AGENTS, EMPLOYEES AND ALL OTHER PERSONS PERFORMING ANY OF THE WORK UNDER A CONTRACT WITH THE CONTRACTOR. THE CONTRACTOR SHALL BE FULLY INSURED WITH LIABILITY AND WORKERS COMPENSATION.
- 8. THE CONTRACTOR SHALL BE RESPONSIBLE FOR THE ADEQUATELY BRACING AND PROTECTING ALL WORK DURING CONSTRUCTION AGAINST DAMAGE, BREAKAGE, COLLAPSE, DISTORTION AND MISALIGNMENT.
- 9. ALL ITEMS REMOVED FROM THE PROJECT SITE DURING THE CONSTRUCTION SHALL REMAIN THE PROPERTY OF THE OWNER EXCEPT THE DEBRIS THAT SHALL BE REMOVED FROM THE PROJECT SITE AND LEGALLY DISPOSED OF ON A
- 10. THE CONTRACTOR SHALL OBTAIN ANY AND ALL PERMITS REQUIRED FOR THE PERFORMANCE OF THE WORK AND THE OWNER SHALL PAY ALL FEES IN CONNECTION WITH THEREOF UNLESS OTHERWISE AGREED UPON.
- 11. THE DESIGN, PREPARATIONS OF NECESSARY CONSTRUCTION DOCUMENTS AND THE SECURING OF ALL REQUIRED PERMITS AND APPROVALS FROM THE APPROPRIATE ADMINISTRATIVE AUTHORITY SHALL BE COMPLETED PRIOR TO THE COMMENCEMENT OF THE WORK AND SHALL INCLUDE ALL WORK.
- 12. DO NOT SCALE DRAWINGS. WRITTEN DIMENSIONS CONFIRMED BY FIELD CONDITIONS TAKE PRECEDENCE. IF A DISCREPANCY ARISES BASED ON FIELD CONDITIONS, CONSULT WITH ARCHITECT BEFORE PROCEEDING WITH WORK OR ORDERING MATERIALS.
- 13. THE CONTRACTOR SHALL NOT MAKE DEVIATIONS FROM THE DESIGN DRAWINGS WITHOUT WRITTEN DIRECTIONS FROM TECH ARCHITECT. REPORT ANY ERRORS, INACCURACIES, MISSING DIMENSIONAL REQUIREMENTS OR CONFLICTS TO THE ARCHITECT/ENGINEER IN WRITING BEFORE BEGINNING ANY WORK. IF THERE IS A DISCREPANCY ON THE CONSTRUCTION DOCUMENTS. THE ARCHITECT SHALL BE NOTIFIED IMMEDIATELY SO THAT THE DISCREPANCIES CAN BE RESOLVED. UNLESS OTHERWISE INDICATED IN WRITING BY ARCHITECT. THE MORE CONSERVATIVE INTERPRETATION OF THE CONSTRUCTION DOCUMENTS SHALL APPLY.
- 14. VERIFY ALL CHANGES TO WORK IN WRITING WITH THE ARCHITECT AND OWNER BEFORE BEGINNING RELATED
- 15. DIMENSIONS NOTED AS "EQUAL" OR "EQ" WITHIN A ROOM REFER TO A DISTANCE RELATIONSHIP CONTAINED ONLY IN THAT ROOM AT AN OPPOSING OR PARALLEL WALL UNLESS NOTED OTHERWISE.
- 16. VERIFY AND ADJUST APPROXIMATE DIMENSIONS (+/-) IN FIELD. VERIFY WITH A/E PRIOR TO CONSTRUCTION.
- 17. ALL ITEMS DETAILED OR SPECIFIED TO RUN WITHIN OR ATTACHED TO WALLS AND CEILINGS ARE TO BE CONCEALED
- 18. ALL SECTIONS AND DETAILS SHALL BE CONSIDERED TYP. AND APPLY FOR THE SAME AND SIMILAR CONDITIONS, UNLESS OTHERWISE SPECIFICALLY NOTED.
- 19. ANY ITEM OF WORK NECESSARY FOR PROPER COMPLETION OF CONSTRUCTION, WHICH IS NOT SPECIFICALLY COVERED ON THE DRAWINGS SHALL BE CONSIDERED INCLUDED IN THIS WORK AND SHALL BE PERFORMED IN A MANNER DEEMED GOOD PRACTICE OF THE TRADE INVOLVED.
- 20. DATUM ELEVATION AT FINISHED FLOOR IS EL: +0'-0". ALL VERTICAL DIMENSIONS FOR THE FLOOR PLANS ELEVATIONS, SECTIONS AND DETAILS ARE REFERENCED FROM THIS DATUM
- 21. ALL WORK SHALL BE PERFORMED IN STRICT ACCORDANCE WITH THE NEW YORK STATE BUILDING CODE, FIRE CODE, PLUMBING CODE, MECHANICAL CODE, ENERGY CONSERVATION CONSTRUCTION CODE, AND WITH THE RULES AND REGULATIONS OF ALL LOCAL AGENCIES, DEPARTMENTS OR LAWS HAVING JURISDICTION OVER ANY PORTION OR
- 22. CONTRACTOR SHALL STRICTLY ADHERE TO MANUFACTURER'S PRINTED INSTRUCTION AND WILL GUARANTEE TO
- OTHERWISE SPECIFIED, AND THAT ALL WORK WILL BE OF GOOD QUALITY AND FREE FROM DEFECTS AND FAULTS FOR ONE (1) YEAR STARTING FROM THE DATE OF SUBSTANTIAL COMPLETION AND ACCEPTANCE OF WORK
- FEDERAL REGULATIONS REGARDING SAFETY IS, AND SHALL BE, THE CONTRACTORS RESPONSIBILITY

- 28. THE CONTRACTOR SHALL INDEMNIFY AND HOLD THE ARCHITECT AND HIS/HER AGENTS HARMLESS FROM AND AGAINST ALL LOSS, DAMAGE OR EXPENSE (INCLUDING REASONABLE ATTORNEY FEES) RESULTING FROM ANY CLAIM OF WHATSOEVER KIND OF NATURE.

PROJECT ADDRESS: 141 DIVISION ST.

FARMINGDALE NY, 11735 TAX MAP #: 49 - 001 - 17

DRAWN BY: BRYAN ZADIK **DATE: 19MAY2025** SCALE: NOT TO SCALE

REVISIONS:

COVER PAGE

G-101P

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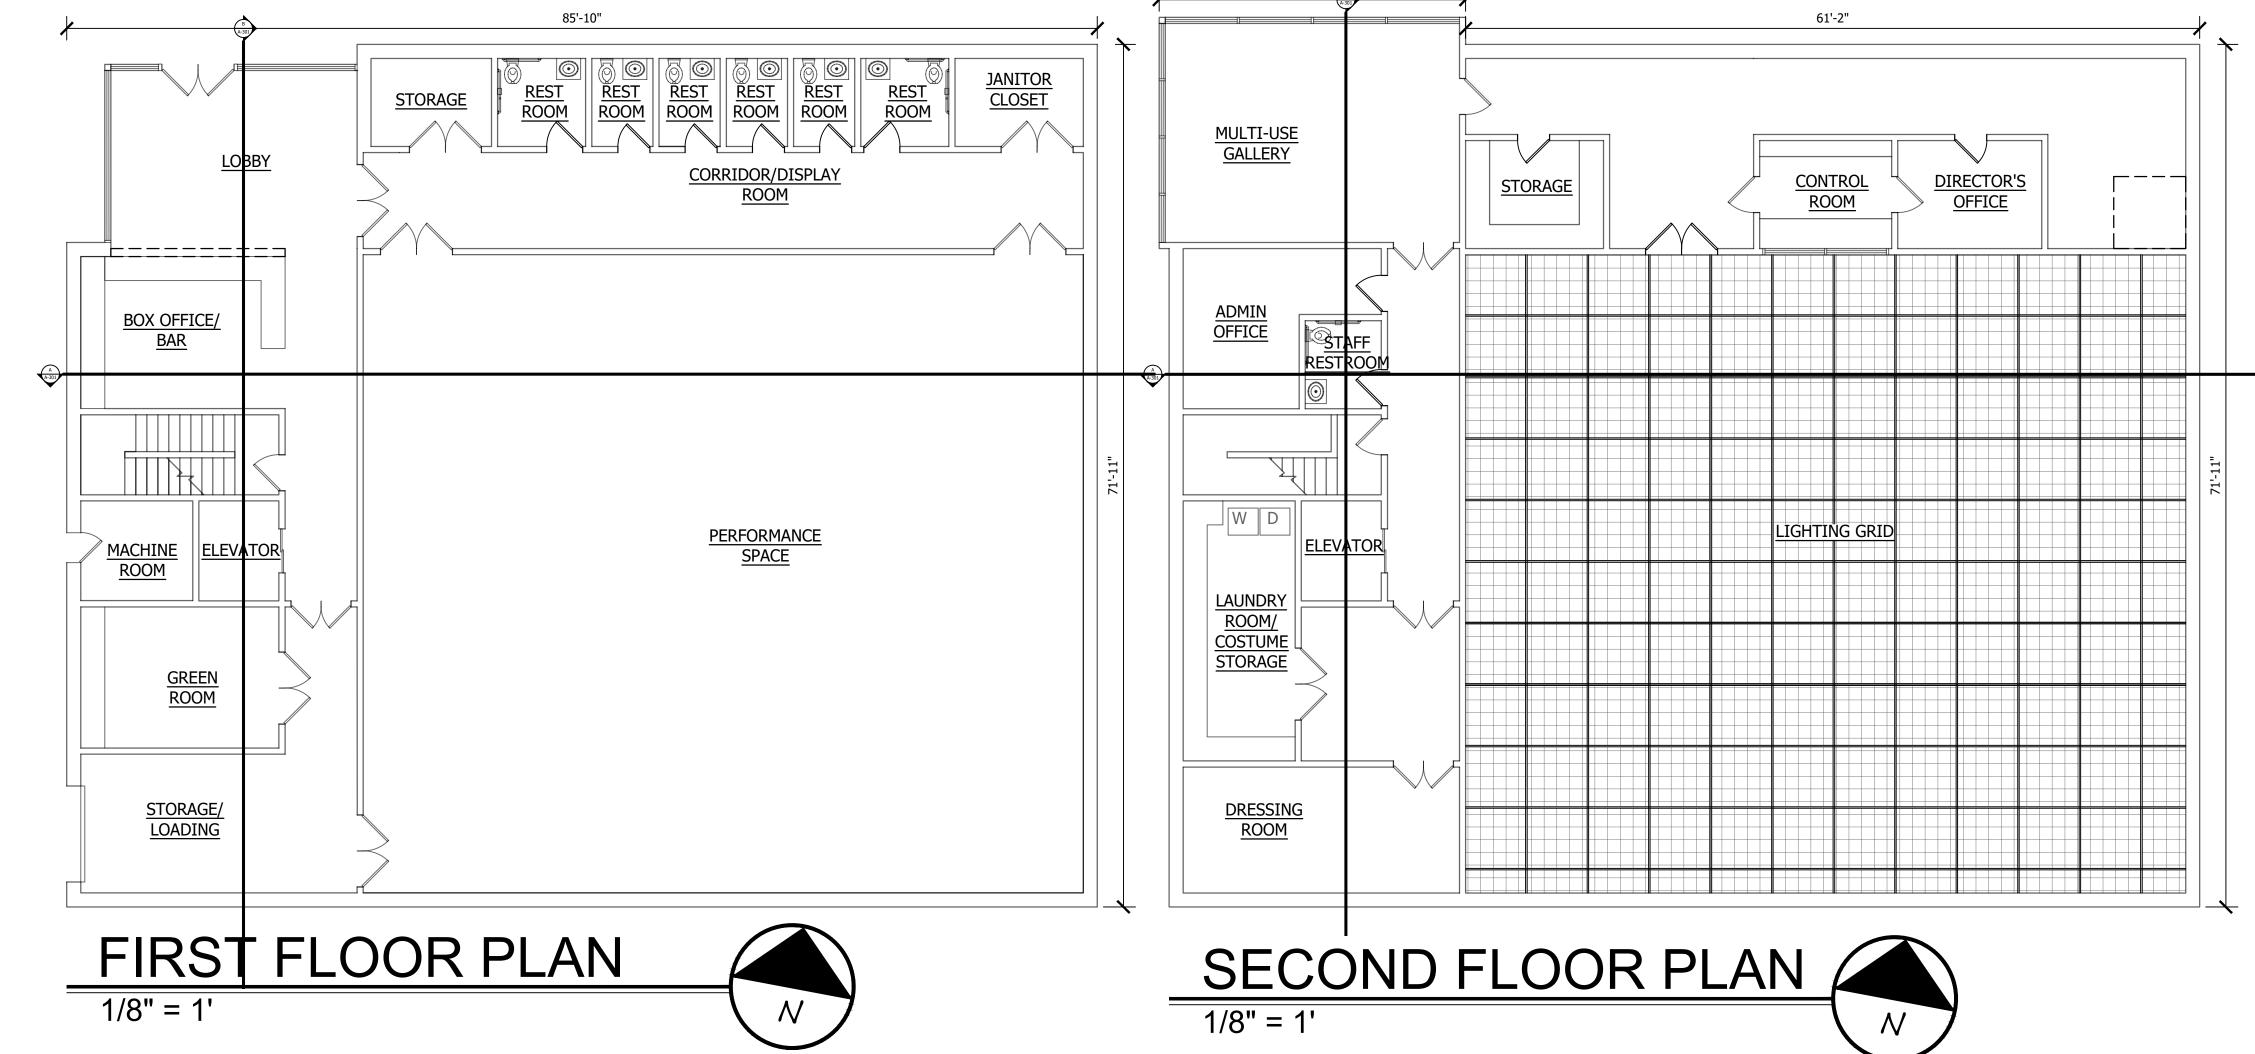
CORNELIA ST **EXISTING SITE PLAN** 1" = 20'

PROJECT NARRATIVE – BLACK BOX THEATER AT 141 DIVISION STREET, FARMINGDALE INTRODUCTION:

- THE VILLAGE OF FARMINGDALE IS PLANNING A PERFORMING ARTS CENTER AT 141 DIVISION STREET TO STRENGTHEN DOWNTOWN CULTURAL LIFE.
- THE PROJECT AIMS TO PROVIDE A FLEXIBLE SPACE FOR THEATER, MUSIC, AND COMMUNITY EVENTS.
- LOCATED ADJACENT TO MAIN STREET AND NEAR THE LIRR STATION, THE BLACK BOX THEATER IS ENVISIONED AS A CIVIC AND CULTURAL ANCHOR THAT PROMOTES CREATIVITY, EDUCATION, AND COMMUNITY ENGAGEMENT.

ARCHITECTURAL CONCEPT: "LANTERN AT THE CORNER":

- DESIGN INSPIRATION: DURING SITE VISITS, LAMP POSTS SCATTERED THROUGH THE PARKING LOT REVEALED A SUBTLE PEDESTRIAN PATH FROM MAIN STREET AND THE LIRR STATION TOWARD DIVISION STREET. THIS BECAME THE BASIS FOR THE "LANTERN" CONCEPT.
- CORNER LANTERN: A GLOWING GLASS VOLUME AT THE NORTHWEST CORNER SERVES AS A VISUAL AND SYMBOLIC BEACON, ORIENTED TOWARD DIVISION AND MAIN STREETS.
- MATERIAL CONTRAST:
 - GLASS VOLUME: PUBLIC LOBBY AND GATHERING ZONE WITH CLEAR VIEWS INTO THE THEATER'S CULTURAL ENERGY.
 - BRICK CORE: ENCLOSES THE BLACK BOX THEATER AND SUPPORT SPACES, OFFERING ACOUSTIC SEPARATION AND FUNCTIONAL PRIVACY.
- SPATIAL STRATEGY: THE BUILDING TRANSITIONS FROM PUBLIC (STREET EDGE) TO PRIVATE (PERFORMANCE ZONE), SUPPORTING INTUITIVE WAYFINDING AND DRAMATIC SPATIAL PROGRESSION.





1" = 20'

DESIGN 4
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FARMINGDALE STATE COLLEGE
2350 BROADHOLLOW ROAD
FARMINGDALE NY 11735

PROPOSED SITE PLAN

CORNELIA ST


LANTERN AT THE CORNER A THEATER FOR THE VILLAGE

PROJECT ADDRESS: 141 DIVISION ST.
FARMINGDALE NY, 11735
TAX MAP #: 49 - 001 - 17
DRAWN BY: BRYAN ZADIK
DATE: 19 MAY2025
SCALE: NOT TO SCALE
REVISIONS:

ARCHITECTURAL PLANS

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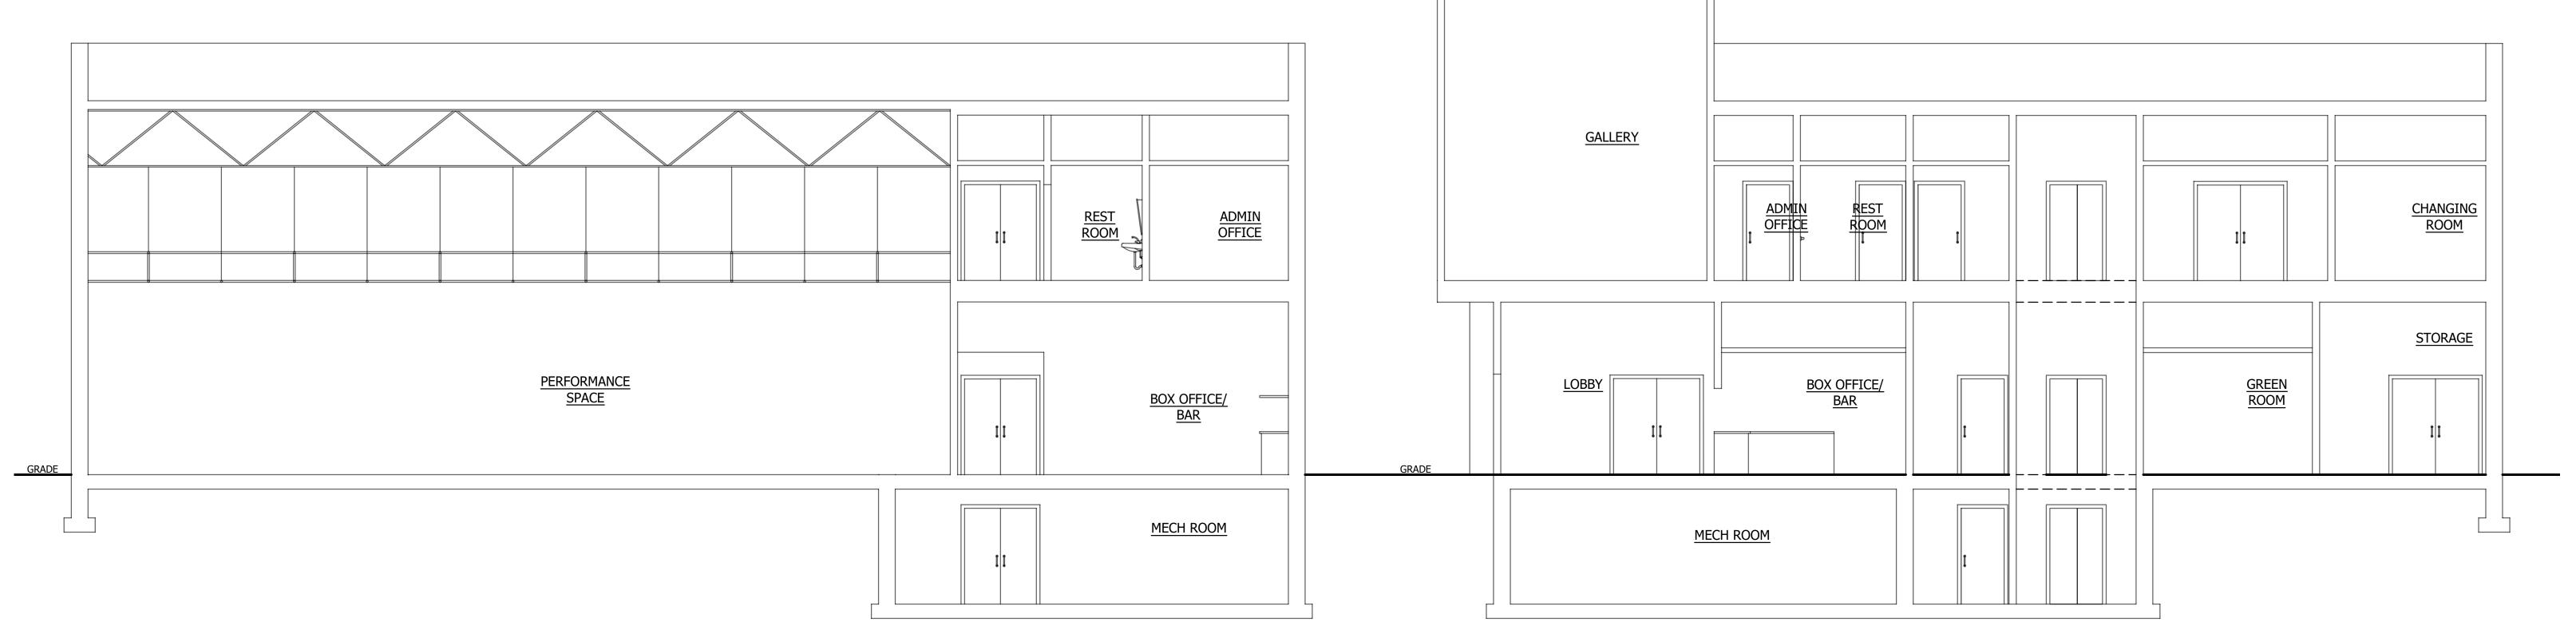


3/16" = 1'

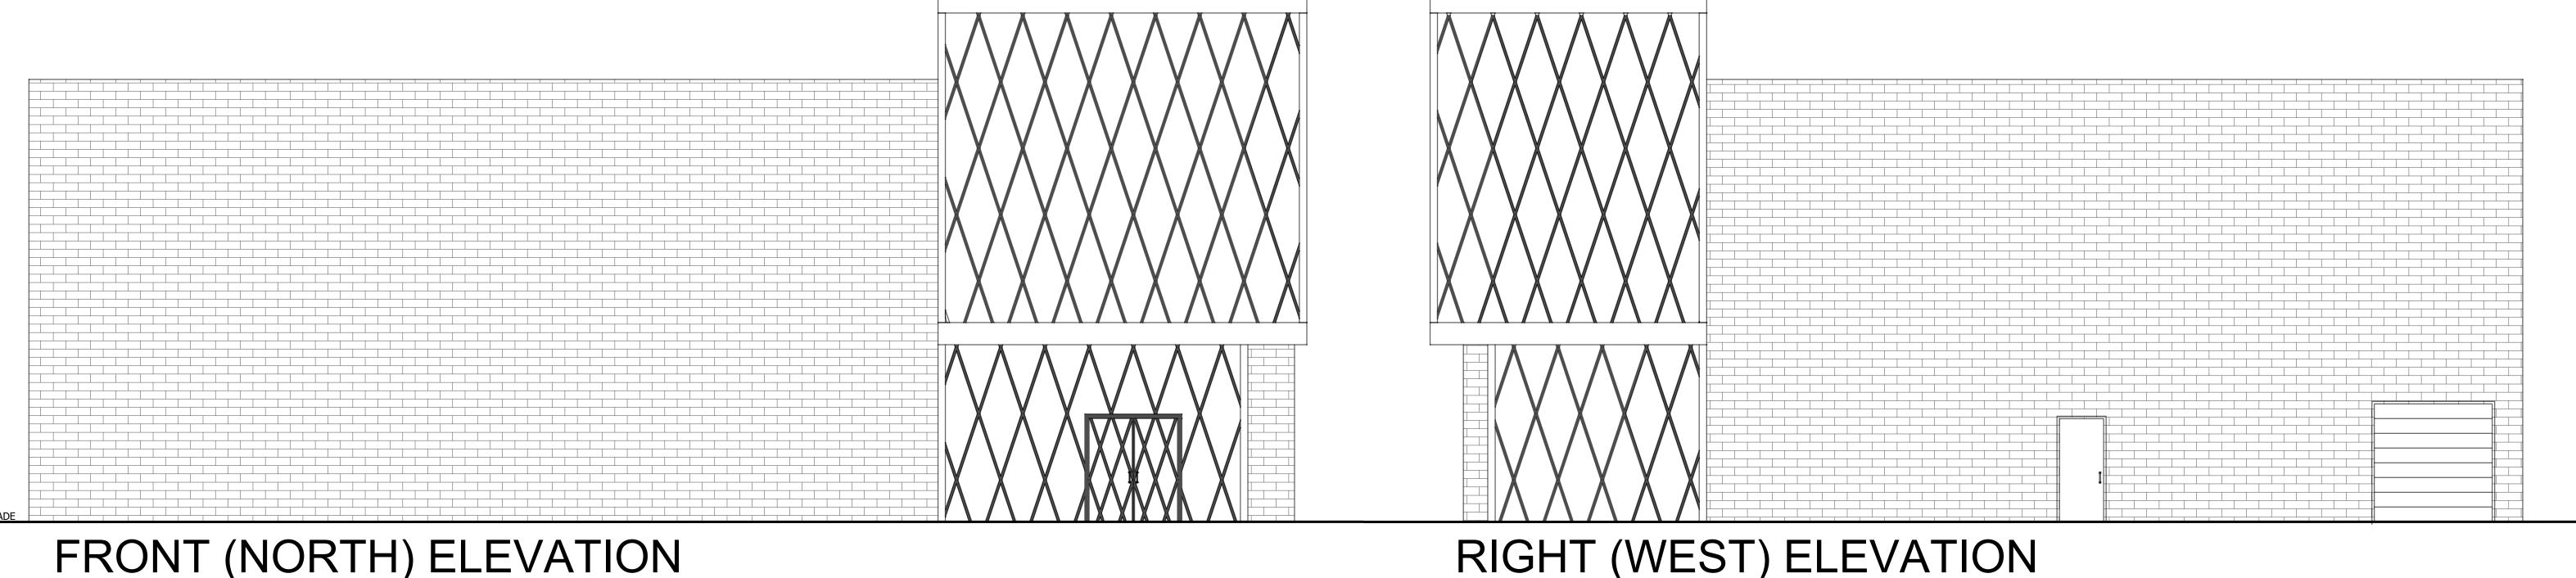LONGITUDINAL SECTION

FRONT (NORTH) ELEVATION

3/16" = 1'



LONGITUDINAL SECTION

3/16" = 1'

LANTERN AT THE CORNER A THEATER FOR THE VILLAGE PROJECT ADDRESS: 141 DIVISION ST. FARMINGDALE NY, 11735 TAX MAP #: 49 - 001 - 17 DRAWN BY: BRYAN ZADIK DATE: 19MAY2025 SCALE: AS NOTED

REVISIONS:


ELEVATION & SECTION

A-201P


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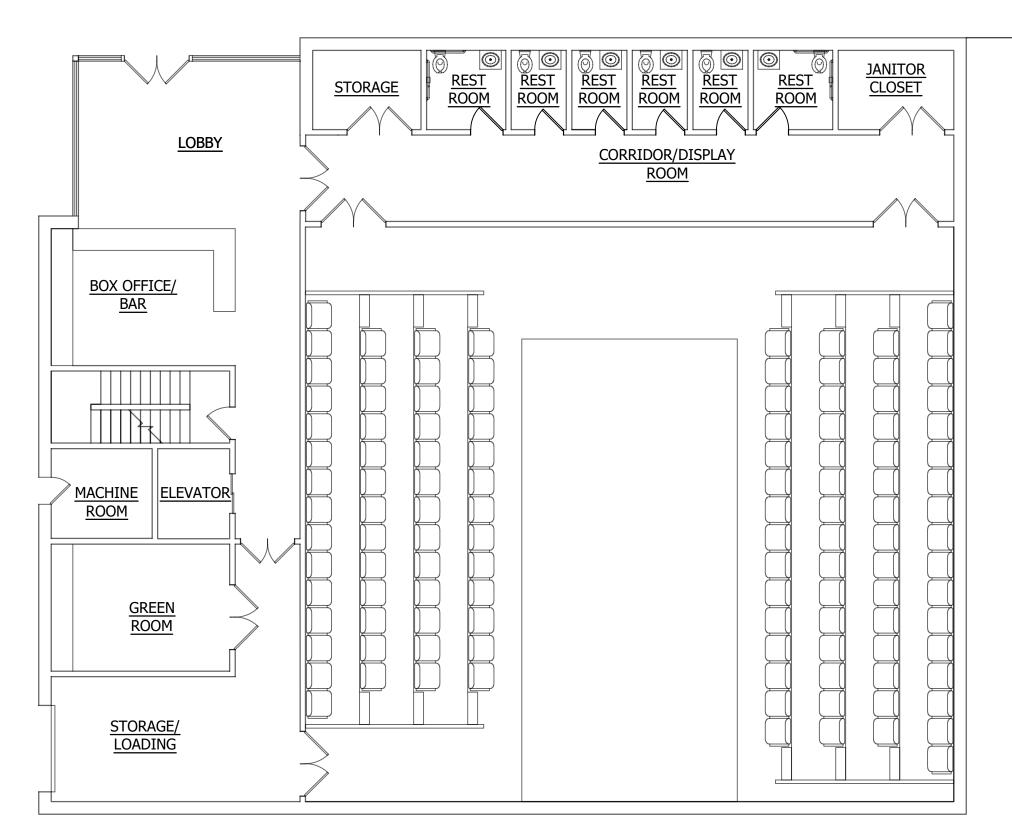
PROFESSOR ANDERSON FARMINGDALE STATE COLLEGE 2350 BROADHOLLOW ROAD FARMINGDALE NY 11735



SEATING ARRANGEMENT 1

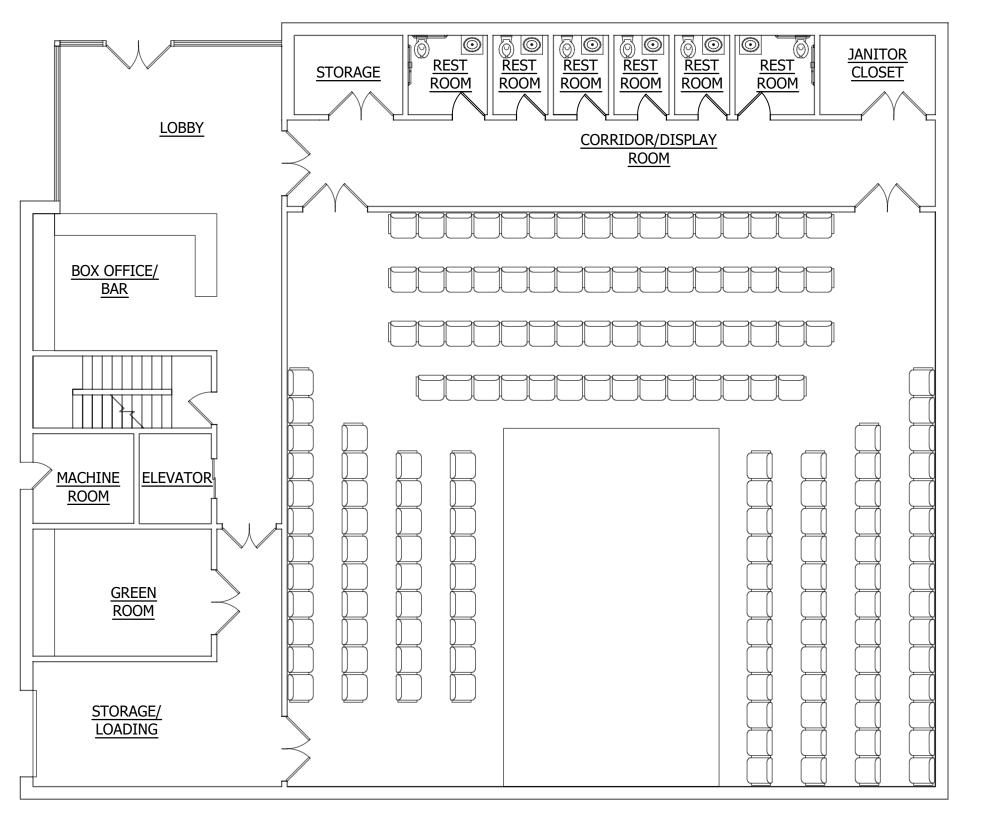


SEATING ARRANGEMENT 3

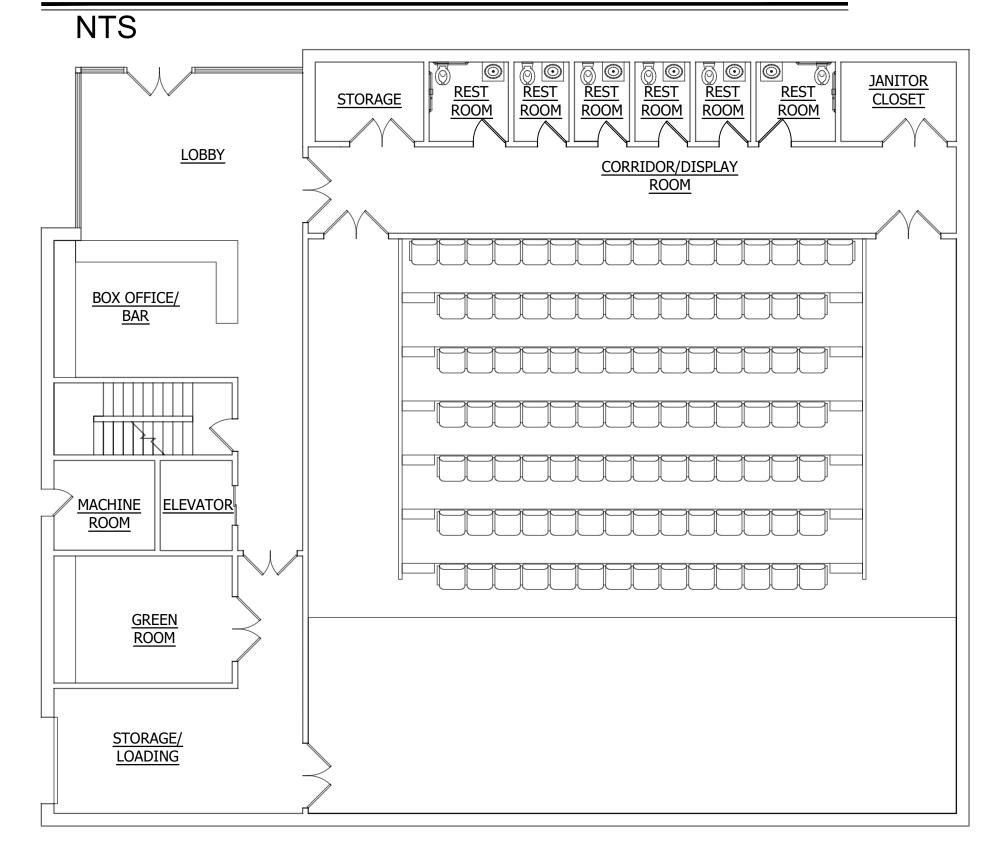

SEATING ARRANGEMENT 2

NTS

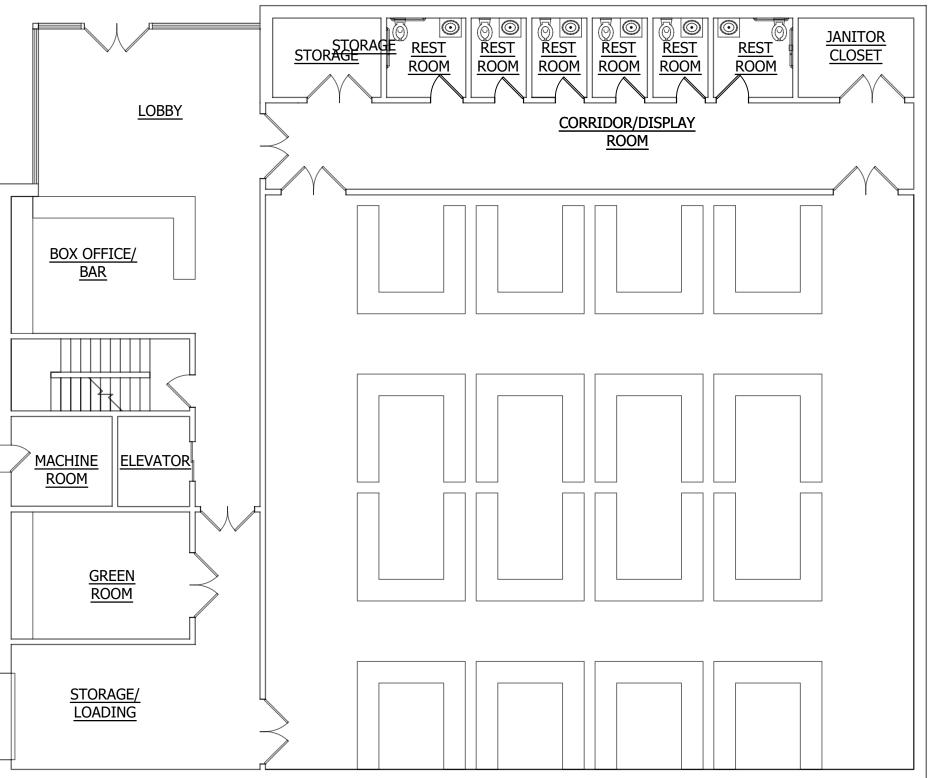

FARMER'S MARKET LAYOUT

SEATING ARRANGEMENT 1 SWOT ANALYSIS

STRENGTHS:

- WITHIN CLIENT'S IDEAL CAPACITY RANGE
- STRONG AUDIENCE FOCUS WITH PROSCENIUM-STYLE SETUP
- HIGH SEAT COUNT INCREASES REVENUE **POTENTIAL**

WEAKNESSES:

- LIMITED STAGING FLEXIBILITY
- MAY REDUCE INTIMACY WITH DISTANT **REAR ROWS**
- HIGH DENSITY SEATING MAY OVERSHADOW THE PERFORMANCE

OPPORTUNITIES:

- **GREAT FOR HIGH-ATTENDANCE**
 - COMMUNITY OR TOURING EVENTS CAN SUPPORT TRADITIONAL

TOTAL NUMBER OF SEAT SEATS: 164

TOTAL NUMBER OF SEAT SEATS: 123

- PERFORMANCES AND RENTALS
- APPEALS TO OUTSIDE PRODUCTION **COMPANIES**

THREATS:

- OVERLY FORMAL FOR EXPERIMENTAL PRODUCTIONS
- MAY DISCOURAGE CREATIVE STAGING **FORMATS**
- HIGHER SEAT COUNT MAY REDUCE SPATIAL FLEXIBILITY

SEATING ARRANGEMENT 2 SWOT ANALYSIS

STRENGTHS:

- BALANCED LAYOUT WITH GOOD SIGHTLINES ALLOWS MORE FLEXIBLE PERFORMANCE USE
- FEELS MORE INTIMATE THAN MAXED-OUT CAPACITY

WEAKNESSES:

- FALLS SHORT OF CLIENT'S SEATING TARGET
- GAPS MAY FEEL UNDERUSED IN LARGER SHOWS
- MAY NOT VISUALLY REFLECT FULL AUDIENCE **ENERGY**

OPPORTUNITIES:

- IDEAL FOR SMALL PLAYS OR STUDENT **PERFORMANCES**
- CAN BE RECONFIGURED FOR IMMERSIVE **PRODUCTIONS**
- SUITED FOR ADAPTABLE EVENT **PROGRAMMING**

THREATS:

- MAY NOT MEET EXPECTATIONS FOR LARGER **EVENTS**
- MID-CAPACITY MAY LIMIT TICKET SALES
- LESS COMPETITIVE FOR MAJOR EVENT **BOOKINGS**

SEATING ARRANGEMENT 3 SWOT ANALYSIS

STRENGTHS:

- HIGHLY INTIMATE AND IMMERSIVE FOR AUDIENCE
- MAXIMIZES PERFORMER-AUDIENCE INTERACTION
- FAST AUDIENCE ENTRY AND EXIT

WEAKNESSES:

- WELL BELOW DESIRED CAPACITY RANGE
- NOT IDEAL FOR LARGER OR REVENUE-DRIVEN **EVENTS**
- COULD LIMIT PUBLIC VISIBILITY OF THE VENUE

OPPORTUNITIES:

PERFECT FOR WORKSHOPS, LABS, OR SMALL

TOTAL NUMBER OF SEAT SEATS: 100

- **ENCOURAGES CREATIVE EXPERIMENTATION**
- CAN SUPPORT ACTOR TRAINING OR STUDENT SHOWCASES

THREATS:

- NOT FINANCIALLY VIABLE FOR LARGE PRODUCTIONS
- MAY UNDERUTILIZE AVAILABLE SPACE
- RISKS BEING PERCEIVED AS A REHEARSAL-ONLY SPACE

SEATING ARRANGEMENT 4 SWOT ANALYSIS

STRENGTHS:

- PROMOTES NON-THEATRICAL COMMUNITY PROGRAMMING
- MAXIMIZES SPACE UTILITY ON DARK DAYS
- ENGAGES DIVERSE USER GROUPS

OPPORTUNITIES:

BRINGS IN NEW USER GROUPS AND TRAFFIC CAN FUNCTION YEAR-ROUND REGARDLESS OF WEATHER

TOTAL NUMBER OF STALLS: 12 10' X 10' STALLS

CREATES PARTNERSHIPS WITH LOCAL **VENDORS**

WEAKNESSES:

- AISLES BETWEEN STALLS MAY FEEL CRAMPED
- LAYOUT MAY LIMIT VENDOR DISPLAY FLEXIBILITY
- INDOOR VENUE LIMITS CIRCULATION COMPARED TO OPEN-AIR MARKETS

THREATS

- INDOOR LAYOUT MAY RESTRICT PRODUCT
- MAY REQUIRE WAYFINDING OR LAYOUT SIGNAGE FOR CLARITY
- VISITORS MAY PREFER LARGER OR **OUTDOOR MARKET EXPERIENCES**



DESIGN 4 PROFESSOR ANDERSON FARMINGDALE STATE COLLEGE 2350 BROADHOLLOW ROAD **FARMINGDALE NY 11735**

LANTERN AT THE CORNER A THEATER FOR THE VILLAGE PROJECT ADDRESS: 141 DIVISION ST. FARMINGDALE NY, 11735

TAX MAP #: 49 - 001 - 17 DRAWN BY: BRYAN ZADIK **DATE: 19MAY2025**

SCALE: NOT TO SCALE **REVISIONS:**

THEATER SEATING CONFIGURATIONS

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Alllocations			
Project Total			\$ 10,938,613
	% Project		
Construction	75%		\$ 8,203,959
Design Contingency	5%		\$ 546,930.63
Project Contingency	5%		\$ 546,930.63
Architects Fees	7%		\$ 765,702.88
Pre-Design Services	3%		\$ 328,158.38
Building Permits	3%		\$ 328,158.38
Reimbursable Expenses	2%		\$ 218,772.25
	100%		\$ 10,938,613
ENTER GROSS SQUARE AREA=	13615		
		cost per	
	GSF	GSF	
Project construction cost per GSF	13,615	\$ 603	

13,615 \$

803

Room Name	Approx. Area (SF)	Description / Use	Code Considerations			
Theater Space		Flexible flat-floor performance space with lighting	Assembly A-1, sprinklered, Class A finishes,			
	3190	grid and riser seating for 150 occupants	accessible egress required			
Lobby		Public entry area with circulation, informational	Accessible route, Class B finishes, must not obstruct			
	318	displays, and gathering space	egress			
Box Office / Bar	216	Combined ticketing and concessions counter with	Plumbing fixtures may be required, accessible			
Green Room	194	Performer lounge and prep space adjacent to stage	Non-rated partition, accessible access, standard			
Dressing Rooms	242	Changing rooms with mirrors, storage, and direct	May require ventilation, ADA dressing room			
Toilet Rooms		Six unisex water closets and lavatories for public				
	37 / 54 (ADA) / 46 (Staff)	and staff use	Meets PCNYS and BCNYS §2902, ADA accessible			
Mechanical Room		Houses HVAC and electrical panels; supports split	Must meet access clearance, ventilation, fire			
	640	system and 600A service	separation			
Storage / Janitor Closet		Storage for props, costumes, maintenance	Standard storage use; may require rated separation			
	522	equipment	if flammable materials stored			
Stairwells and Elev. Shaft	507 (169 per floor)	Two enclosed stairwells and one elevator shaft for	Stair enclosures must be rated; elevator per ASME			
Hallways / Circulation	1684	General interior circulation including corridors and	Minimum 44" clear width; Class B finishes			
Gallery		Large multi-use gallery with glass walls to draw in	Must contribute to no more than the 30% glazing			
	448	pedestrians	limit per ECCCNYS			

NEW CONSTRUCTION/RENOVATION			Gross Square Area	Со	st per GSF	Cost by Task/Facility
New Construction for project Type IIA Use Group A-1			13615	\$	452	\$ 6,158,009.17
Site Improvements - hardscape	Imperviou	is Surfaces	831	\$	20	\$ 16,620.00
Site Improvements - landscape	Landscaped Areas		910	\$	15	\$ 13,650.00
Tariff 25% increase materials = 10% increase costs			15356	\$	24	\$ 374,145.82
Premium cost for custom glass structure			1,283	\$	58	\$ 74,760.41

ency				Ψ	6,637,185.40
		Subtotal	x Factor		
	\$	-	5%	\$	-
	\$	6,637,185.40	-3%	\$	(199,115.56
	\$	6,637,185.40	-5%	\$	(331,859.27
	\$	-	7%	\$	-
	\$	6,637,185.40	20%	\$	1,327,437.08
	\$	6,637,185.40	2%	\$	132,743.71
	\$	-	-2%	\$	-
	\$	6,637,185.40	-2%	\$	(132,743.71
	\$	6,637,185.40	5%	\$	331,859.27
	\$	-	5%	\$	-
	\$	-	7%	\$	-
	\$	-	10%	\$	-
	\$	6,637,185.40	-3%	\$	(199,115.56
	\$	-	-1%	\$	-
	\$	6,637,185.40	5%	\$	331,859.27
	\$	-	5%	\$	-
	\$	6,637,185.40	7%	\$	464,602.98
				\$	1,725,668.20
0% of subtotals				\$	1,672,570.72
RUCTION+FEES+FA	AC 7	TORS+OVERHE	AD/PROFIT	\$	10,035,424.32
	0% of subtotals	\$ \$ \$ \$ \$ \$ \$ \$ \$ \$ \$ \$ \$ \$ \$ \$ \$ \$ \$	\$ 6,637,185.40 \$ 6,637,185.40 \$ 6,637,185.40 \$ 6,637,185.40 \$ 6,637,185.40 \$ 6,637,185.40 \$ - \$ 6,637,185.40 \$ - \$ 6,637,185.40 \$ - \$ 6,637,185.40 \$ - \$ 6,637,185.40	\$ - 5% \$ 6,637,185.40 -3% \$ 6,637,185.40 -5% \$ - 7% \$ 6,637,185.40 20% \$ 6,637,185.40 2% \$2% \$ 6,637,185.40 5% \$ 6,637,185.40 5% \$ - 5% \$ - 7% \$ - 10% \$ 6,637,185.40 -3% \$ - 10% \$ 6,637,185.40 5% \$ - 5% \$ - 7% \$ 6,637,185.40 5% \$ - 5% \$ 6,637,185.40 5% \$ 6,637,185.40 5% \$ 6,637,185.40 5% \$ 6,637,185.40 5% \$ 6,637,185.40 5% \$ 6,637,185.40 5% \$ 6,637,185.40 5%	\$ - 5% \$ \$ 6,637,185.40 -3% \$ \$ 6,637,185.40 -5% \$ \$ - 7% \$ \$ 6,637,185.40 20% \$ \$ 6,637,185.40 20% \$ \$ 6,637,185.40 2% \$ \$2% \$ \$ 6,637,185.40 -2% \$ \$ 6,637,185.40 5% \$ \$ - 5% \$ \$ - 5% \$ \$ - 10% \$ \$ 6,637,185.40 -3% \$ \$ - 10% \$ \$ 6,637,185.40 -3% \$ \$ 5 - 10% \$ \$ 6,637,185.40 5% \$ \$ 5 - 5% \$ \$ 6,637,185.40 7% \$ \$ 6,637,185.40 5% \$ \$ 6,637,185.40 7% \$ \$ 6,637,185.40 5% \$ \$ 5 - 5% \$ \$ 6,637,185.40 5% \$ \$ 5 - 5% \$ \$ 6,637,185.40 5% \$ \$ 5 - 5% \$ \$ 6,637,185.40 5% \$ \$ 5 - 5% \$ \$ 6,637,185.40 5% \$ \$ 5 -

30BIOTAL, CONSTRUCTION+FEE3+FACTORS+OVERHEAD/FROFIT \$	10,035,424.32
Years to	
Midpoint	
Previous Subtotal x 5%x no. of years to	

903,188.19 1.5 **Escalation** midpoint construction

TOTAL PROJECT ESTIMATE=

10,938,612.51



Project costs per GSF

PROFESSOR ANDERSON FARMINGDALE STATE COLLEGE 2350 BROADHOLLOW ROAD FARMINGDALE NY 11735

LANTERN AT THE CORNER A THEATER FOR THE VILLAGE PROJECT ADDRESS: 141 DIVISION ST. FARMINGDALE NY, 11735

TAX MAP #: 49 - 001 - 17 DATE: 19MAY2025

DRAWN BY: BRYAN ZADIK SCALE: NOT TO SCALE REVISIONS:


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PROGRAM & BUDGET

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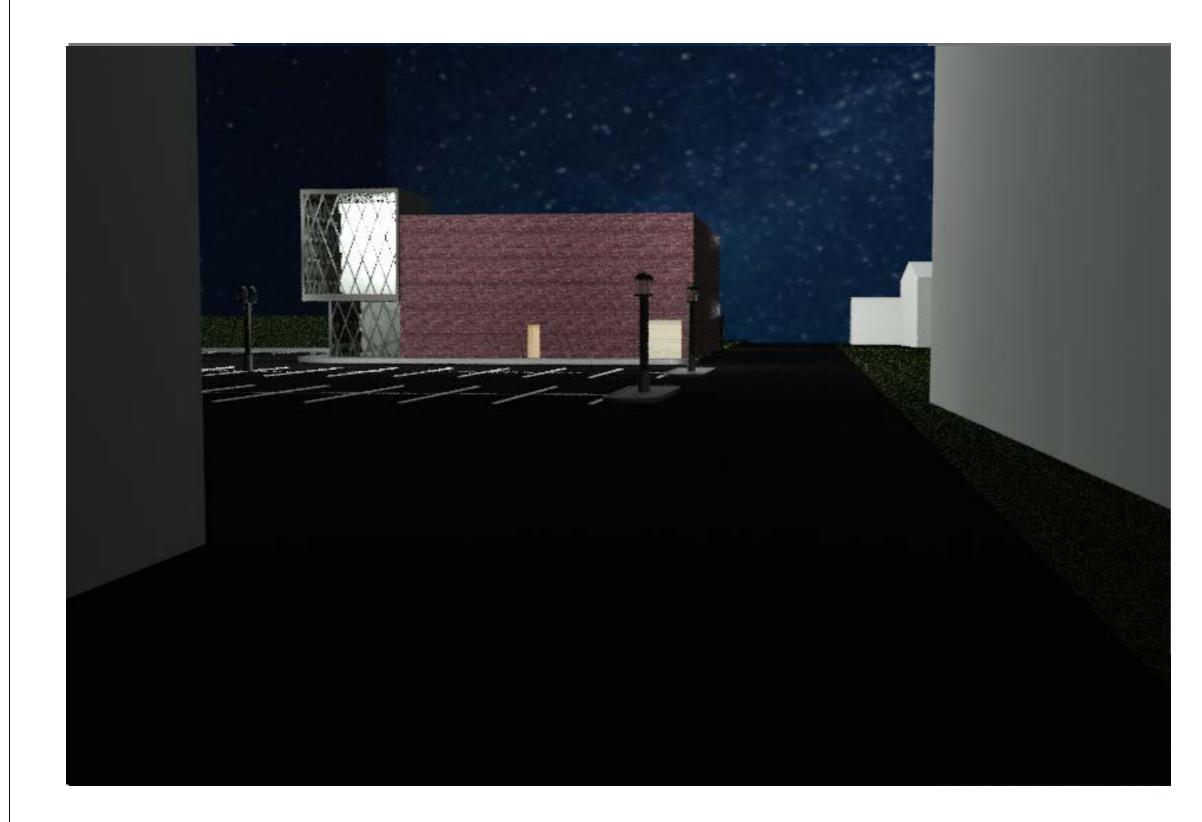
ENTRANCE VIEW




BIRD'S EYE VIEW

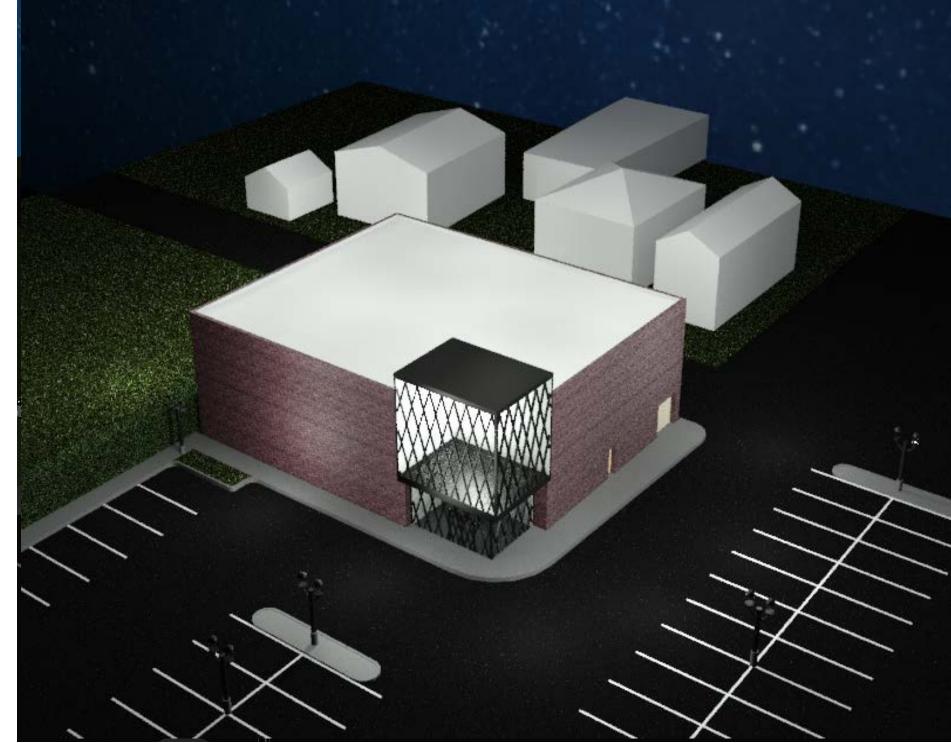


FRONT STREET VIEW




MAIN STREET VIEW

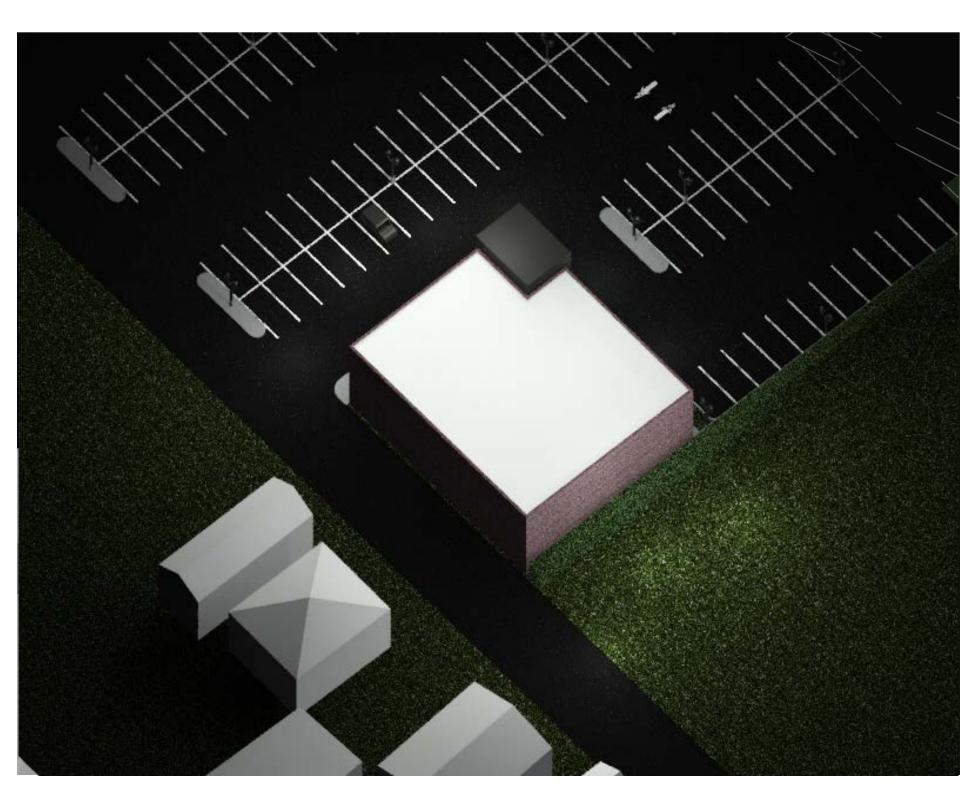

REAR BIRD'S EYE VIEW

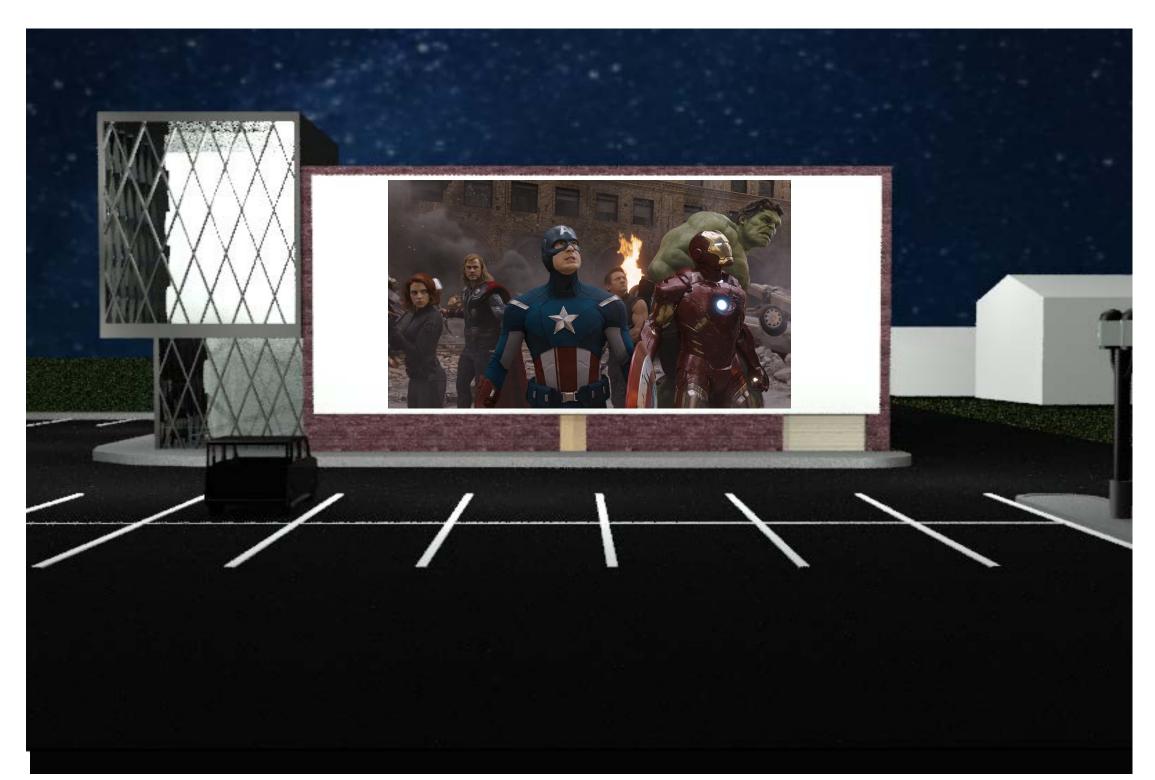

MOVIE NIGHT

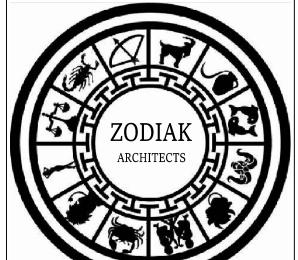

DESIGN 4
PROFESSOR ANDERSON
FARMINGDALE STATE COLLEGE
2350 BROADHOLLOW ROAD
FARMINGDALE NY 11735

LANTERN AT THE CORNER A THEATER FOR THE VILLAGE

PROJECT ADDRESS: 141 DIVISION ST.

FARMINGDALE NY, 11735

TAX MAP #: 49 - 001 - 17

DRAWN BY: BRYAN ZADIK DATE: 19MAY2025

SCALE: NOT TO SCALE REVISIONS:

EXTERIOR RENDERINGS

A-901P

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